

MISSION HILLS FREMONT CNU3909/G009

45123 LYNX DRIVE FREMONT, CA 94539-6058

PROJECT INFORMATION

PROJECT DESCRIPTION:

AT&T PROPOSES TO MODIFY AN EXISTING UNSTAFFED TELECOMMUNICATIONS FACILITY BY ADDING (2) LTE PANEL ANTENNAS (1 PER SECTOR) ON AN EXISTING JPA WOOD UTILITY POLE. INSTALLATION ALSO INCLUDES AN EXTENSION OF THE EXISTING EQUIPMENT ENCLOSURE WITH A RETENTION WALL AREA HOUSING (1) RBA72 CABINET, (2) PURCELL CABINETS (STACKED), (1) GPS ANTENNA AND (4) RRH UNITS MOUNTED ON AN H-FRAME.

AT&T 4430 ROSEWOOD DRIVE BLDG 3, FLOOR 6 PLEASANTON, CA, 94588

CODE INFORMATION;

ZONING CLASSIFICATION: N/A CONSTRUCTION TYPE: 1/B OCCUPANCY: S-2

JURISDICTION: CITY OF FREMONT CURRENT USE: TELECOMMUNICATIONS FACILITY

PROPOSED USE: TELECOMMUNICATIONS FACILITY

SITE LOCATION: (BASED ON NAD 83):

LONGITUDE: -121.81633 TOP OF STRUCTURE AGL: 46'-0" BASE OF STRUCTURE AMSL: 31'-4"

EXISTING LEASE AREA: ±70' - 0"

PROPOSED LEASE AREA:

ERICSSON, INC.
6160 STONERIDGE MALL ROAD, SUITE 400
PLEASANTON, CA 94588
CONTACT: DENISE CORREA
PH: (954) 604–9031

SITE ACQUISITION:

PERMITTING:

CONSTRUCTION MANAGER:

ERICSSON, INC. 6160 STONEBRIDGE MALL ROAD SUITE 400 PLEASANTON, CA 94588 CONTACT: BRYAN SUNDHOLM PH: (360) 540–9266

GENERAL INFORMATION:

1. PARKING REQUIREMENTS ARE UNCHANGED.

2. TRAFFIC IS UNAFFECTED.

PROJECT TEAM

PROJECT ARCHITECT

THOMAS HOLLAND, AIA
PACIFIC TELECOM SERVICES, LLC
3825 HOPYARD ROAD, SUITE 182
PLEASANION, CA 94598
CONTACT: RENE SANCHEZ
PH: (925) 577—9800
EMAIL: RSANCHEZ®PTSWA.COM

PROJECT CONSULTANT

ERICSSON INC. 6160 STONEBRIDGE MALL ROAD SUITE 400 PLEASANTON, CA 94588

PROPERTY & POLE OWNER: NORTHERN CALIFORNIA JOINT POLE ASSOCIATION 785 MARKET ST SAN FRANCISCO, CA 94103 PHONE: (925) 681-0378

TEAM LEAD:

JEAM LEAU: ERICSSON, INC. 6160 STONEBRIDGE MALL ROAD SUITE 400 PLEASANTON, CA 9458B CONTACT: DENISE CORREA PH: (954) 604-9031

SITE ACQUISITION MANAGER:

REALCOM 3825 HOPYARD ROAD, SUITE 182 PLEASANTON, CA 94588 CONTACT: MATT YERCOVICH PH: (415) 596-3474

REALCOM 3825 HOPYARD ROAD, SUITE 182 PLEASANTON, CA 94588 CONTACT: MATT YERGOVICH PH: (415) 596-3474

PROJECT CONSULTANT

DRAWING INDEX

GENERAL NOTES & SYMBOLS SITE PLAN EXISTING EQUIPMENT PLAN PROPOSED EQUIPMENT PLAN EXISTING & PROPOSED ANTENNA PLAN EQUIPMENT DETAILS CONSTRUCTION DETAILS

RE DETAILS SCHEMATIC GROUNDING PLAN GROUNDING DETAILS GROUNDING DETAILS

TRAFFIC CONTROL PLAN ENLARGED TRAFFIC CONTROL PLAN

SHEET DESCRIPTION EXISTING & PROPOSED SOUTH ELEVATION EXISTING & PROPOSED NORTH ELEVATION

LANDSCAPING PLAN & DETAILS

CODE COMPLIANCE

EXHIBIT "A" File #: PLN 2012- 000 43

as submitted

FEB 2 3 2012

Knistie Weller

with conditions

Granted

☐ Denied

2010 BUILDING STANDARDS ADMINISTRATION CODE

- PART 1, TITLE 24, C.C.R
2010 CALIFORNIA BUILDING CODE (CBC)

- PART 2, TITLE 24, C.C.R.
2009 INTERNATIONAL BUILDING CODE (IBC)

- VOLUMES 1-3 & CALIFORNIA AMENDMENTS
2010 CALIFORNIA ELECTRICAL CODE (CEC)

- PART 3, TITLE 24, C.C.R.
2009 NATIONAL ELECTRICAL CODE (MEC)

2009 NATIONAL ELECTRICAL CODE (NEC)

— INCLUDING 2010 CALIFORNIA AMENDMENTS
2010 CALIFORNIA MECHANICAL CODE (CMC)

— PART 4, ITILE 24, C.C.R.
2009 INTERNATIONAL MECHANICAL CODE (IMC)

— INCLUDING 2010 CALIFORNIA AMENDMENTS
2010 CALIFORNIA PLUMBING CODE (CPC)

— PART 5, ITILE 24, C.C.R.
2009 INTERNATIONAL PLUMBING CODE (CPC)

— INCLUDING 2010 CALIFORNIA AMENDMENTS
2010 CALIFORNIA ENFRGY CODE (CFC)

— PART 8, ITILE 24, C.C.R.
2004 ASME A17.1 SAFETY CODE

— FOR ELEVATORS AND ESCALATORS
2010 CALIFORNIA FIRE CODE (CFC)

— PART 9, ITILE 24, C.C.R.
2009 INTERNATIONAL FIRE CODE (CFC)

— INCLUDING 2010 CALIFORNIA AMENDMENTS
2010 CALIFORNIA FIRE CODE (CFC)

— INCLUDING 2010 CALIFORNIA AMENDMENTS
2010 CALIFORNIA REFERENCED STANDARDS

— PART 12, ITILE 24, C.C.R.

— TITLE 19, C.C.R.

PUBLIC SAFETY, STATE FIRE MARSHAL REGULATIONS
ANSI/EIA/TIA—222—G STANDARDS FOR BROADCAST
STRUCTURES, LOCAL CODES AND ORDINANCES. 2009 NATIONAL ELECTRICAL CODE (NEC)
- INCLUDING 2010 CALIFORNIA AMENDMENTS

IN THE EVENT OF A CONFLICT, THE MOST RESTRICTIVE CODE SHALL PREVAIL.

DRIVING DIRECTIONS

START FROM REGIONAL OFFICE:

CIII

VICINITY MAP

DEPART ROSEWOOD DR TOWARD OLD SANTA RITA RD TURN LEFT ONTO SANTA RITA RD 0,4 M! TAKE RAMP RIGHT FOR I-580 WEST / ARTHUR H BREED FWY TOWARD OAKLAND 2.6 MI AT EXIT 44B, TAKE RAMP RIGHT FOR 1-680 SOUTH / SINCLAIR FWY TOWARD SAN JOSE 17.4 MI AT EXIT 12, TAKE RAMP RIGHT AND FOLLOW SIGNS FOR SR-262 EAST / MISSION BLVD KEEP STRAIGHT ONTO MISSION BLVD 0.8 MI TURN RIGHT ONTO ANTELOPE DR, AND THEN IMMEDIATELY TURN LEFT ONTO LYNX DR ARRIVE AT 45123 LYNX DR, FREMONT, CA 94539-6058 ON THE LEFT

APPROVAL	DATE	SIGNATURE	APPROVAL	DATE	SIGNATURE
RF ENGINEER:			LANDLORD:		
RF MANAGER:			SITE ACQUISITION:		
OPPS MANAGER:			ZONING AGENT:		
CONSTR MANAGER:			PROJECT MANAGER:		
NSB MANAGER:			CONSTR MANAGER:		
TRANSPORT:					
EQUIP ENGINEER:					
COMPLIANCE:					
REVIEWERS S	HALL CLEAR	RLY PLACE INITIALS ADJACENT TO	EACH REDUNE NOT	F AS DRAV	VINGS ARE BEING REVIEWED

ABBR EVIATIONS

	ADI	DICE VI/ATION	10			
	A/C AGL APPROX	AIR CONDITIONING ABOVE GROUND LEVEL APPROXIMATELY	HORZ HR HT HVAC	HORIZONTAL HOUR HEIGHT HEATING	PLYWD PROJ PROP PT	PLYWOOD PROJECT PROPERTY PRESSURE TREATED
	BLDG BLK	BUILDING BLOCKING	11110	VENTILATION AIR CONDITIONING	REO RF	REQUIRED RADIO FREQUENCY
	CLG CLR COAX CONC	CEILING CLEAR COAXIAL CABLE CONCRETE	ID IN INFO INSUL	INSIDE DIAMETER INCH INFORMATION INSULATION	RM RO RRH	ROOM ROUGH OPENING REMOTE RADIO HEAD
	CONST CONT	CONSTRUCTION CONTINUOUS DOUBLE	IBC	INTERIOR INTERNATIONAL BUILDING CODE	SHT SIM SPEC SF	SHEET SIMILAR SPECIFICATION SOUARE FOOT
	DIA DIAG DN	DIAMETER DIAGONAL DOWN	LBS LTE MAX	POUNDS LONG TERM EVOLUTION MAXIMUM	SS STL STRUCT STD	STAINLESS STEEL STEEL STRUCTURAL STUD
	DET DWG	DETAIL DRAWING	MECH MTL	MECHANICAL METAL	SUSP	SUSPENDED
	EA ELEV ELEC EQ	EACH ELEVATION ELEGTRICAL EQUAL	MFR MGR MJN MISC	MANUFACTURE MANAGER MINIMUM MISGELLANEOUS	THRU TNNG TYP	THROUGH TINNED TYPICAL
_	EQUIP EXT	EQUIPMENT EXTERIOR	NA NIC	NOT APPLICABLE NOT IN CONTRACT	UNO VERT	UNLESS NOTED OTHERWISE VERTICAL
_	FIN FLUOR FLR FT	FINISH FLUORESCENT FLOOR FOOT	OC OD	NOT TO SCALE ON CENTER OUTSIDE DIAMETER	W/ W/O	VERIFY IN FIELD WITH WITHOUT
	GA GALV GC	GAUGE GALVANIZED GENERAL CONTRACTOR		ON SIDE SAMETER	WP	WATER PROOF

at&t





FREMON

45123 LYNX DRIVE FREMONT, CA. 94539—6058

NU3909/G009

MISSION

03/18/11 ISSUED FOR CONSTRUCTION BO NOT FOR CONSTRUCTION UNLESS LABELED AS CONSTRUCTION SET

> SHEET TITLE TITLE SHEET

SHEET NUMBER

THE INFORMATION CONTAINED IN THIS SET OF CONSTRUCTION DOCUMENTS IS PROPRIETARY BY NATURE. ANY USE OR DISCLOSURE OTHER THAN THAT WHICH RELATES TO CARRIER SERVICES IS STRICTLY PROHIBITED

GENERAL NOTES:

- THE CONTRACTOR SHALL NOTIFY TOWER NETWORK CARRIER OF ANY ERRORS, OMISSIONS, OR INCONSISTENCIES AS THEY MAY BE DISCOVERED IN PLANS, DOCUMENTS, NOTES, OR SPECIFICATIONS PRIOR TO STARTING CONSTRUCTION INCLUDING, BUT NOT LIMITED BY, DENOLITION. THE CONTRACTOR SHALL BE RESPONSIBLE FOR CORRECTING ANY ERROR, OMISSION, OR INCONSISTENCY AFTER THE START OF CONSTRUCTION WHICH HAS NOT BEEN BRIGUIST TO THE ATTENTION OF TOWER NETWORK CARRIER CONSTRUCTION PROJECT MANAGER AND SHALL INCUR ANY EXPENSES TO RECTIFY THE SITUATION. THE MEANS OF CORRECTING ANY ERROR SHALL FIRST BE APPROVED BY TOWER NETWORK CARRIER CONSTRUCTION PROJECT MANAGER.
- PRIOR TO THE SUBMISSION OF BIDS, CONTRACTORS INVOLVED SHALL VISIT THE JOB SITE TO FAMILIARIZE THEMSELYES WITH ALL CONDITIONS AFFECTING THE PROPOSED PROJECT. CONTRACTORS PRIOR TO THE COMMENCEMENT OF CONSTRUCTION, THE CONTRACTOR HAVING BEEN AWARDED THIS PROJECT SHALL VISIT THE CONSTRUCTION SITE WITH THE CONSTRUCTION/CONTRACT DOCUMENTS TO VERIFY FIELD CONDITIONS AND CONFIRM THAT THE PROJECT WILL BE ACCOMPUSHED AS SHOWN, PRIOR TO PROCECEDING WITH CONSTRUCTION, ANY ERRORS, OMISSIONS, OR DISCREPANCIES SHALL BE BROUGHT TO THE ATTENTION OF THE ARCHITECT/ENGINERY REPROBLY AND IN WENTING. ARCHITECT/ENGINEER VERBALLY AND IN WRITING.
- FOR COLLOCATION SITES: CONTACT TOWER OWNER REPRESENTATIVE FOR
- 5. THE ARCHITECTS/ENGINEERS HAVE MADE EVERY EFFORT TO SET FORTH IN THE CONSTRUCTION AND CONTRACT DOCUMENTS THE COMPLETE SCOPE OF WORK. CONTRACTORS BIDDING THE JOB ARE NEVERTHELESS CAUTIONED THAT MINOR OMISSIONS OF ERRORS IN THE DRAWINGS AND OR SPECIFICATIONS SHALL NOT EXCUSE SAID CONTRACTOR FROM COMPLETING THE PROJECT AND IMPROVEMENTS IN ACCORDANCE WITH THE INTENT OF THESE DOCUMENTS. THE BIDDER SHALL BEAR THE RESPONSIBILITY OF NOTIFYING (IN WRITING) THE AIRCHITECT/ENGINEER OF ANY CONFLICTS, ERRORS, OR OMISSIONS PRIOR TO SUBMISSION OF CONTRACTOR'S PROPOSAL. IN THE EVENT OF DISCREPANCIES THE CONTRACTOR'S PROPOSAL. IN THE EVENT OF EXTENSIVE WORK, UNLESS DIRECTED OTHERWISE.
- . DRAWINGS ARE NOT TO BE SCALED UNDER ANY CIRCUMSTANCE, TOWER NETWORK CARRIER IS NOT RESPONSIBLE FOR ANY ERRORS RESULTING FROM THIS PRACTICE WRITTEN DIMENSIONS TAKE PRECEDENCE OVER SCALE SHOWN ON PLANS.
- OWNER, CONTRACTOR, AND TOWER NETWORK CARRIER CONSTRUCTION PROJECT MANAGER SHALL MEET JOINTLY TO VERIFY ALL DRAWINGS AND SPECIFICATIONS PRIOR TO THE START OF CONSTRUCTION.
- THE GENERAL CONTRACTOR SHALL RECEIVE WRITTEN AUTHORIZATION TO PROCEED WITH CONSTRUCTION PRIOR TO STARTING WORK ON ANY ITEM NOT CLEARLY DEFINED BY THE CONSTRUCTION DRAWINGS/CONTRACT DOCUMENTS.
- 9. THE CONTRACTOR SHALL PERFORM WORK DURING OWNER'S PREFERRED HOURS TO AVOID DISTURBING NORMAL BUSINESS.
- 10. THE CONTRACTOR SHALL PROVIDE TOWER NETWORK CARRIER PROPER INSURANCE CERTIFICATES NAMING TOWER NETWORK CARRIER AS ADDITIONAL INSURED, AND TOWER NETWORK CARRIER PROOF OF LICENSE(S) AND PE & PD INSURANCE.
- 11. THE CONTRACTOR SHALL SUPERVISE AND DIRECT THE PROJECT DESCRIBED IN THE CONTRACT DOCUMENTS. THE CONTRACTOR SHALL BE SOLELY RESPONSIBLE FOR ALL CONSTRUCTION MEANS, METHODS, TECHNIQUES, SEQUENCES, AND PROCEDURES FOR COORDINATING ALL PORTIONS OF 1 WORK UNDER THE CONTRACT.
- 12. THE CONTRACTOR SHALL INSTALL ALL EQUIPMENT AND MATERIALS ACCORDING TO MANUFACTURER'S/VENDOR'S SPECIFICATIONS UNLESS NOTED OTHERWISE OR WHERE LOCAL CODES OR ORDINANCES TAKE PRECEDENCE.
- 5. ALL WORK PERFORMED ON THE PROJECT AND MATERIALS INSTALLED SHALL BE IN STRICT ACCORDANCE WITH ALL APPLICABLE CODES, REGULATIONS, AND ORDINANCES. CONTRACTOR SHALL GIVE ALL NOTICES AND COMPLY WITH ALL LAWS, ORDINANCES, RULES, REGULATIONS AND LAWFUL ORDERS OF ANY PUBLIC AUTHORITY, MUNICIPAL AND UTILITY COMPANY SPECIFICATIONS, AND LOCAL AND STATE JURISDICTIONAL CODES BEARING ON THE PERFORMANCE OF THE WORK.
- 15. A COPY OF GOVERNING AGENCY IS APPROVED PLANS SHALL BE KEPT IN A PLACE SPECIFIED BY THE GOVERNING AGENCY, AND BY LAW, SHALL BE AVAILABLE FOR INSPECTION AT ALL TIMES. THE ORIGINAL PERMIT SET PLANS ARE NOT TO BE USED BY THE WORKMEN, ALL CONSTRUCTION SETS SHALL REFLECT THE SAME INFORMATION AS GOVERNING AGENCY APPROVED PLANS. THE CONTRACTOR SHALL ALSO MAINTAIN ONE SET OF PLANS, IN GOOD CONDITION, COMPLETE WITH ALL REVISIONS, ADDENDA, AND CHANGE ORDERS ON THE PREVISES AT ALL TIMES UNDER THE DIRECT CARE OF THE SUPERITEDENT. THE CONTRACTOR SHALL SUPPLY TOWER NETWORK CARRIER CONSTRUCTION PROJECT MANAGER. WITH A COPY OF ALL REVISIONS, ADDENDA, AND AND THE WORK AS ADDENDA, AND/OR CHANGE ORDERS AT THE CONCLUSION OF THE WORK AS A PART OF THE AS-BUILT DRAWING RECORDS.
- 16. THE STRUCTURAL COMPONENTS OF ADJACENT CONSTRUCTION OR FACILITIES ARE NOT TO BE ALTERED BY THIS CONSTRUCTION PROJECT UNLESS NOTED OTHERWISE.
- 17. THE CONTRACTOR SHALL STUDY THE STRUCTURAL, ELECTRICAL, MECHANICAL, AND PLUMBING PLANS AND CROSS CHECK THEIR DETAILS, NOTES, DIMENSIONS, AND ALL REQUIREMENTS PRIOR TO THE START OF ANY WORK.
- 18. THE CONTRACTOR SHALL BE RESPONSIBLE FOR THE COMPLETE SECURITY OF THE PROJECT AND SITE WHILE THE WORK IS IN PROGRESS UNTIL THE JOB
- 19. THE CONTRACTOR HAS THE RESPONSIBILITY OF LOCATING ALL EXISTING UTILITIES WHETHER OR NOT SHOWN ON THE PLANS, AND TO PROTECT THEN FROM DAMAGE. THE CONTRACTOR, OR SUBCONTRACTOR AS SPECIFIED IN TH AGREEMENT BETWEEN SUBCONTRACTOR AND CONTRACTOR, SHALL BEAR THE EXPENSES OF REPAIR AND/OR REPLACEMENT OF UTILITIES OR OTHER PROPERTY DAMAGE BY OPERATIONS IN CONJUNCTION WITH THE EXECUTION OF THE WORK.
- 20. THE REFERENCES ON THE DRAWINGS ARE FOR CONVENIENCE ONLY AND SHALL NOT LIMIT THE APPLICATION OF ANY DRAWING OR DETAIL.
- 21. ALL DIMENSIONS ON THE PLANS ARE TO FACE OF STUD (F.O.S.) UNLESS NOTED OTHERWISE (U.N.O.).

- 22. ALL EXISTING CONSTRUCTION, EQUIPMENT, AND FINISHES NOTED TO BE REMOVED SHALL BECOME THE PROPERTY OF THE CONTRACTOR AND WILL BE REMOVED FROM THE SITE WITH THE FOLLOWING EXCEPTIONS: A. PROPERTY NOTED TO BE RETURNED TO THE OWNER.
 - B. PROPERTY NOTED TO BE REMOVED BY THE OWNER.
- 23. THE GOVERNING AGENCIES, CODE AUTHORITIES, AND BUILDING INSPECTORS SHALL PROVIDE THE MINIMUM STANDARDS FOR CONSTRUCTION TECHNIQUES, MATERIALS, AND FINISHES USED THROUGHOUT THE PROJECT. TRADE STANDARDS AND/OR PUBLISHED MANUFACTURERS SPECIFICATIONS MEETING OR EXCEEDING DESIGN REQUIREMENTS SHALL BE USED FOR INSTALLATION
- 24. WHEN REQUIRED STORAGE OF MATERIALS OCCURS, THEY SHALL BE EVENLY WILLIAM REGULATED OVER ROUGH FRAMED FLOORS OR ROOFS SO AS NOT TO EXCEED THE DESIGNED LIVE LOADS FOR THE STRUCTURE. TEMPORARY SHORING AND/OR BRAGING IS TO BE PROVIDED WHERE THE STRUCTURE HAS NOT ATTAINED THE DESIGN STRENGTH FOR THE CONDITIONS PRESENT.
- 25. PRIOR TO THE POURING OF ANY NEW SLAB OVER AN EXISTING SLAB THE CONTRACTOR SHALL VERIFY LOCATIONS OF ALL OPENINGS, CHASES, AND EQUIPMENT WHICH ABE TO BE IMPLEMENTED INTO THE NEW WORK. ALL ITEMS DESIGNATED TO BE ABANDONED SHALL BE NOTED AND DISCUSSED WITH THE CWINER AND TOWER NETWORK CARRIER CONSTRUCTION PROJECT MANAGER AS PART OF THE AS—BULL DRAWING PACKAGE.
- 26. SEAL ALL PENETRATIONS THROUGH FIRE-RATED AREAS WITH U.L. LISTED OR FIRE MARSHALL APPROVED MATERIALS IF APPLICABLE TO THIS FACILITY AND OR PROJECT SITE.
- 27. BUILDING INSPECTORS AND/OR OTHER BUILDING OFFICIALS ARE TO SE NOTIFIED PRIOR TO ANY GRADING, CONSTRUCTION, AND ANY OTHER PROJECT EFFORT AS MANDATED BY THE GOVERNING AGENCY.
- 28. CONTRACTOR TO PROVIDE A PORTABLE FIRE EXTINGUISHER WITH A RATING OF NOT LESS THAN 2—A OR 2—A10BC WITHIN 75 FEET TRAVEL DISTANCE TO ALL PORTRUCTONS OF PROJECT AREA DURING CONSTRUCTION.
- 29. THE PROJECT, WHEN COMPLETED, SHALL COMPLY WITH LOCAL SECURITY CODES AND TITLE-24 ENERGY CONSERVATION REQUIREMENTS. (TITLE-24 WHEN APPLICABLE)
- 30. ALL GLASS AND GLAZING IS TO COMPLY WITH CHAPTER 54 OF THE U.S. CONSUMER SAFETY COMMISSION SAFETY STANDARDS FOR ARCHITECTURAL GLAZING MATERIALS (42 FR 1428, CFR PART 1201) AND LOCAL SECURITY REQUIREMENTS.
- 31. CONTRACTOR SHALL MAKE NECESSARY PROVISIONS TO PROTECT EXISTING IMPROVEMENTS, EASEMENTS, PAVING, CURBING, ETC. DURING CONSTRUCTIC UPON COMPLETION OF WORK, CONTRACTOR SHALL REPAIR ANY DAMAGE THAT MAY HAVE OCCURRED DUE TO CONSTRUCTION ON OR ABOUT THE STRUCTION
- 32. CONTRACTOR SHALL KEEP GENERAL WORK AREA CLEAN AND HAZARD FREE DURING CONSTRUCTION AND DISPOSE OF ALL DIRT, DEBRIS, AND RUBBISH CONTRACTOR SHALL REMOVE EQUIPMENT NOT SPECIFIED AS REMAINING ON THE PROPERTY OR PREMISES. SITE SHALL BE LEFT IN CLEAN CONDITION AND FREE FROM PAINT SPOTS, DUST, OR SMUDGES OF ANY NATURE.
- 33. NEW CONSTRUCTION ADDED TO EXISTING CONSTRUCTION SHALL MATCH IN FORM, TEXTURE, FINISH, AND IN MATERIALS EXCEPT AS NOTED IN THE PLANS AND SPECIFICATIONS
- 34. THE CONTRACTOR SHALL PROVIDE ALL NECESSARY BACKING, BLOCKING, AND/OR SLEEVES REQUIRED FOR THE INSTALLATION OF FIXTURES, MECHANICAL EQUIPMENT, PLUMBING, HARDWARE, AND FINISH ITEMS TO INSURE A PROPER AND COMPLETE JOB.
- 35. THE CONTRACTOR IS RESPONSIBLE FOR PROVIDING A PROJECT LEVEL STRAIGHT, AND TRUE ACCORDING TO THE PLANS. THE CONTRACTOR SHALL COMPARE THE LINES AND LEVELS OF THE EXISTING CONDITIONS WITH THOSE SHOWN ON THE PLANS PRIOR TO THE START OF ANY CONSTRUCTION. TOWER NETWORK CARRIER SHALL BE NOTIFIED OF ANY ERRORS, OMISSIONS, OR INCONSISTENCIES PRIOR TO ANY CONSTRUCTION.
- 36. THE CONTRACTOR IS TO PROVIDE PROTECTION FOR ADJOINING PROPERTIES FROM PHYSICAL HARM, NOISE, DUST, DIRT, AND FIRE AS REQUIRED BY THE GOVERNING AGENCIES.
- 37. WHERE SPECIFIED, MATERIALS TESTING SHALL BE TO THE LATEST STANDARDS AND/OR REVISIONS AVAILABLE AS REQUIRED BY THE GOVERNING AGENCY RESPONSIBLE FOR RECORDING THE RESULTS.
- 38. THE CONTRACTOR IS RESPONSIBLE FOR THE STORAGE OF ALL MATERIALS AND SHALL NOT DO SO ON PUBLIC PROPERTY WITHOUT A PERMIT TO DO SO FROM THE GOVERNING AGENCIES FOR THIS PURPOSE.
- 39. GENERAL NOTES AND STANDARD DETAILS ARE THE MINIMUM REQUIREMENTS TO BE USED IN CONDITIONS WHICH ARE NOT SPECIFICALLY SHOWN OTHERWISE.
- 40. TRADES INVOLVED IN THE PROJECT SHALL BE RESPONSIBLE FOR THEIR OWN CUTTING, FITTING, PATCHING, ETC., SO AS TO BE RECEIVED PROPERLY BY THE WORK OF OTHER TRADES.
- 41. ALL DEBRIS AND REFUSE IS TO BE REMOVED FROM THE PROJECT PREMISES AND SHALL BE LEFT IN A CLEAN (BROOM FINISH) CONDITION AT ALL TIMES BY EACH TRADE AS THEY PERFORM THEIR OWN PORTION OF THE WORK.
- 42. TOWER NETWORK CARRIER DOES NOT GUARANTEE ANY PRODUCTS, FIXTURES, AND/OR ANY EQUIPMENT NAMED BY A TRADE OR MANUFACTURER. GUARANTEE OR WARRANTY THAT MAY BE IN EFFECT IS DONE SO THROUGH THE COMPANY OR MANUFACTURER PROVIDING THE PRODUCT, FIXTURE, AND/OR EQUIPMENT ONLY: UNLESS SPECIFIC RESPONSIBILITY IS ALSO PROVIDED BY THE CONTRACTOR/SUBCONTRACTOR IN WRITTEN FORM.
- 43. CAUTIONI CALL BEFORE YOU DIGI BURIED UTILITIES EXIST IN THE AREA AND UTILITY INFORMATION SHOWN MAY NOT BE COMPLETE. CONTACT THE ONE-CALL UTILITY LOCATE SERVICE A MINIMUM OF 48 HOURS PRIOR TO CONSTRUCTION. 1-800-227-2600.
- 44. CONTRACTOR TO REPLACE AND/OR REPOUTE ANY EXISTING UNDERGROUND UTILITIES ENCOUNTERED DURING TRENCHING AND GENERAL CONSTRUCTION.
- 45 WHEN APPLICABLE CONTRACTOR IS RESPONSIBLE TO CALL COORDINATE AND MAKE ARRANGEMENTS FOR ROW AND/OR PRIVATE PROPERTY LOCATE
 MODIFICATION CONSTRUCTION; BASED ON SPECIFIC SITE REQUIREMENTS.
- 46. SEE CIVIL DRAWINGS FOR ADDITIONAL SITE INFORMATION
- 47. CONTRACTORS TO DOCUMENT ALL WORK PERFORMED WITH PHOTOGRAPHS AND SUBMIT TO TOWER NETWORK CARRIER ALONG WITH REDLINED CONSTRUCTION SET.
- 48. CONTRACTOR SHALL DOCUMENT ALL CHANGES MADE IN THE FIELD BY MARKING UP (REDLINING) THE APPROVED CONSTRUCTION SET AND SUBMITTING THE REDLINED ALONG WITH PHOTOGRAPHS PER NETWORK

- 49. GENERAL CONTRACTOR IS TO COORDINATE ALL POWER INSTALLATION WITH POWER COMPANY AS REQUIRED. CONTRACTOR TO REPORT POWER INSTALLATION COORDINATION SOLUTION(S) TO NETWORK CARRIER REPRESENTATIVE, PROJECT CONSTRUCTION MANAGER AND ARCHITECT.
- 51. THE GENERAL CONTRACTOR SHALL BE RESPONSIBLE FOR AND SHALL REMEDY ALL FAULTY, INFERIOR, AND/OR IMPROPER MATERIALS, DAMAGED GOODS, AND/OR FAULTY WORKMANSHIP FOR ONE (1) YEAR ATER THE PROJECT IS COMPETE AND ACCEPTED UNDER THIS CONTRACT; UNLESS NOTED OTHERWISE IN THE CONTRACT BETWEEN THE OWNER AND THE CONTRACTOR (EXCEPTION) THE ROOPING SUBGONIFACTOR SHALL FURRISH A MAINTENANCE AGREEMENT FOR ALL WORK DONE, COSIGNED BY THE GENERAL CONTRACTOR, TO MAINTAIN THE ROOPING IN A WATERTIGHT CONDITION FOR A PERIOD OF TWO (2) YEARS STARTING AFTER THE DATE OF SUBSTANTIAL COMPLETION OF THE PROJECT, UNLESS OTHERWISE WRITTEN IN THE CONTRACT BETWEEN THE OWNER AND THE CONTRACTOR.
- 52. THE CONTRACTOR SHALL PROVIDE ADEQUATE PROTECTION FOR THE SAFETY OF THE OWNER'S EMPLOYEES, WORKMEN, AND ALL TIMES DURING THE CONSTRUCTION OF THE PROJECT.
- 53. THE CONTRACTOR SHALL BE REQUIRED TO PAY FOR ALL NECESSARY PERMITS AND/OR FEES WITH RESPECT TO THE WORK TO COMPLETE THE PROJECT. BUILDING PERMIT APPLICATIONS SHALL BE FILED BY THE OWNER OR HIS REPRESENTATIVE. CONTRACTOR SHALL OBTAIN PERMIT AND MAKE FINAL PAYMENT FOR SAID DOCUMENT.
- 54 NOT USED
- 55, TOWER NETWORK CARRIER WILL REVIEW AND APPROVE SHOP DRAWINGS AND SAMPLES FOR CONFORMANCE WITH DESIGN CONCEPT. TOWER NETWORK CARRIER PROJECT APPROVAL OF A SEPARATE ITEM SHALL NOT INCLUDE APPROVAL OF AN ASSEMBLY IN WHICH THE ITEM FUNCTIONS.
- 56. ALL ANTENNAS MOUNTED ON ROOF SUPPORT FRAMES TO BE PROVIDED BY
- 57. CONTRACTOR TO PROVIDE TRENCH AS REQUIRED TO INSTALL BOTH ELECTRICAL AND TELEPHONE UNDERGROUND CONDUITS (

 #40 PVC) PER S.C.E. WORKORDER. BACKFILL WITH CLEAN SAND AND COMPACT TO THE SATISFACTION OF THE DISTRICTS INSPECTOR. REPLACE FINISH GRADE WITH MATCHING MATERIALS (GRASS, ASPHALT, CONCRETE, ETC.)
- 58, CONTRACTOR TO PROVIDE HEAVY STEEL PLATES AT OPEN TRENCHES FOR SAFETY AND TO PROTECT EXISTING GROUND SURFACES FROM HEAVY EQUIPMENT UTILIZED DURING CONSTRUCTION.
- 59, CONTRACTOR TO PATCH AND REPAIR ALL GROUND SURFACES WITHIN THE CONSTRUCTION AREA AS NECESSARY TO PROVIDE A UNIFORM SURFACE AND MAINTAIN EXISTING SURFACE DRAIMAGE SLOPES.
- 60. CONTRACTOR TO REPLACE LANDSCAPE VEGETATION THAT WAS DAMAGED DUE TO CONSTRUCTION, AND TO MODIFY REMAINING IRRIGATION LINES TO OPERATING CONDITION, PROVIDING FULL COVERAGE TO IMPACTED AREAS.
- 61, IN THE CASE OF ROOFTOP SOLUTIONS FOR EQUIPMENT AND/OR ANTENNA FRAMES WHERE PENETRATION OF EXISTING ROOFING MATERIALS OCCUR, THE GENERAL CONTRACTOR SHALL COORDINATE WITH BUILDING OWNER AND BUILDING ROOFING CONTRACTOR OF RECORD FOR INSTALLATION, PATCH, REPAIR OR ANY AUGMENTATION TO THE ROOF, AND HAVE THE WORK GUARANTED UNDER THE ROOFING CONTRACTOR'S WARRANTY FOR MOISTURE PENETRATION OR AND OTHER FUTURE BREACH OF ROOFING INTEGRITY.
- 62 IN THE CASE OF PROPETOR SOLUTIONS WITH THE INSTALLATION OF ANTENNAS WITHIN IN THE CASE OF ROOFIOP SOLUTIONS WITH THE INSTALLATION OF ANTENNAS WITHIN CONCEALED (SHROULDE) SUPPORT FRAMES ON TRIPOSS, THE GENERAL CONTRACTOR SHALL COORDINATE WITH THE FEP DESIGNER/FABRICATOR TO ENSURE THAT THE FINAL FRP SHROULD IS SIMULATING (IN APPEARANCE) DESIGNATED EXISTING EXTERNOR BUILDING FACADE MATERIALS, TEXTURES, AND COORS. THE CONTRACTOR SHALL FROM THE WASTER OF COUNTERSON FASTER OF SHALL FROM THE CONSTRUCTION. WHEN PHOTOSIMULATIONS ARE PROVIDED, THE CONTRACTOR SHALL ENSURE THAT FINAL CONSTRUCTION REPRESENTS WHAT IS INDICATED IN PHOTOSIMULATION. SHOP DRAWINGS SHALL BE PROVIDED TO THE GENERAL CONTRACTION TO PREPARE AND ARCHITECT PRIOR TO FABRICATION AND CONSTRUCTION COORDINATOR, AND ARCHITECT PRIOR TO FABRICATION AND CONSTRUCTION.
- 63. IN THE CASE OF ROOFTOP SOLUTIONS FOR EQUIPMENT AND/OR ANTENNA FRAMES WHERE ANOHORING TO A CONCRETE ROOF SLAB IS REQUIRED, CONTRACTORS SHALL CONFIRM (PRIOR TO SUBMITTING BID) WITH CONSULTING CONSTRUCTION COORDINATOR AND ARCHITECT THE PRESENCE OF POST TENSION TREDOONS WITHIN THE ROOF SLAB RESULTING FROM AN UNDOCUMENTED DESIGN CHANGE IN THE EXISTING BUILDING "AS-BUILT DRAWING SET" — HAVING INDICATED AN ORIGINAL DESIGN SOLUTION OF REINFORCED CONCRETE W/ EMBEDDED STEEL REBAR. IN THE EVENT POST TENSION SLAB SOLUTION IS PRESENT, CONTRACTOR SHALL INCLUDE PROVISIONS FOR X-RAY ROCEDURES (INCLUDED IN BID) FOR ALL PENETRATION AREAS WHERE ANCHORING
- 64. GENERAL & SUB CONTRACTORS SHALL USE STAINLESS STEEL METAL LOCKING TIES FOR GENERAL & SUB CONTRACTIONS SHALL USE STAINLESS STELL METAL LOCKING THE FOR ALL CABLE TRAY, TIE DOWNS AND ALL OTHER GENERAL TIE DOWNS (WHERE APPLICABLE). PLASTIC ZIP TIES SHALL NOT BE PERMITTED FOR USE ON TOWER NETWORK CARRIER PROJECTS. RECOMMENDED MANUFACTURE SHALL BE: PANDUIT CORP. METAL LOCKING TES MODEL NO. MLT4S—CP UNDER SERIES—304 (OR EQUAL). PANDUIT PRODUCT DISTRIBUTED BY TRIARC.
- 65 NOT USED

TOWER/POLE NOTES:

- VERIFICATION THAT THE EXISTING TOWER/POLE CAN SUPPORT THE PROPOSED ANTENNA LOADING IS TO BE DONE BY OTHERS.
- PROVIDE SUPPORTS FOR THE ANTENNA COAX CABLES TO THE ELEVATION OF ALL INITIAL AND FUTURE ANTENNAS. ANTENNA COAX CABLES ARE TO BE SUPPORTED AND RESTRANDED AT THE CENTERS SUITABLE TO THE MANUFACTURER'S REQUIREMENTS.

SYMBOLS:

(x)GRID REFERENCE



OFTAIL REFERENCE



ELEVATION REFERENCE



SECTION REFERENCE

- MATCH LINE

----- CENTERLINE PROPERTY/LEASE LINE

WORK POINT

GROUND CONDUCTOR ---- T---- TFLEPHONE CONDUIT ----- F----- FLECTRICAL CONDUIT

--- A ----- COAXIAL CABLE _____O/H.....OVERHEAD SERVICE CONDUCTORS

GROUT OR PLASTER

E) BRICK WWW. (E) MASONRY

CONCRETE

EARTH GRAVEL

WARREN PLYWOOD

SAND WOOD CONTINUOUS

WOOD BLOCKING

VIVIOUS STEEL

(N) NFW

(E)

4,5 EXISTING ANTENNA

0 GROUND ROD

GROUND BUS BAR

MECHANICAL GRND, CONN

8 CADWELD

8

Œ ELECTRIC BOX

TELEPHONE BOX

公 LIGHT POLE

 \circ FND MONUMENT

SPOT ELEVATION

Δ SET POINT

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EXHIBIT "A" File #: PLNZ012-00043

☑ Granted

as submitted

with conditions

☐ Denied

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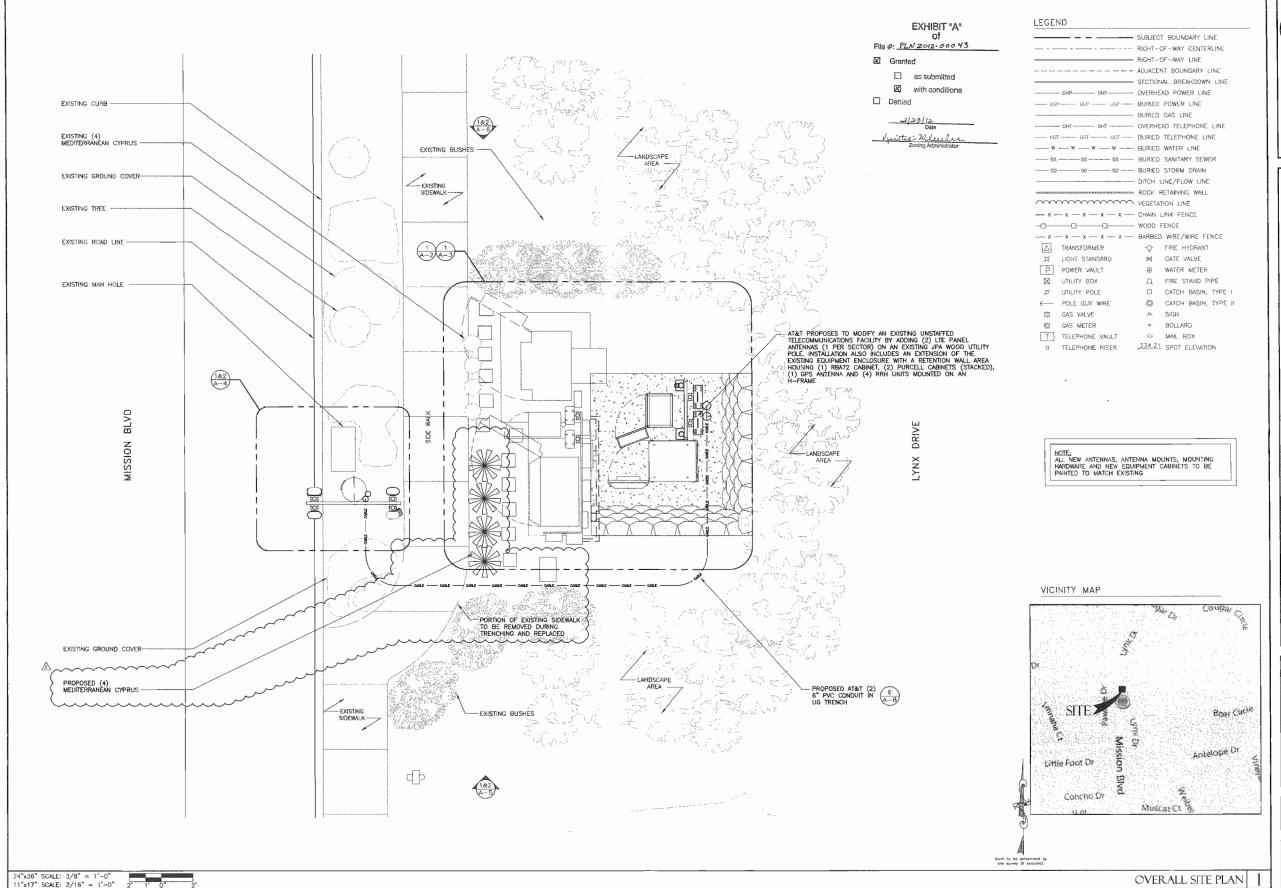
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> SHEET TITLE GENERAL NOTES & SYMBOLS







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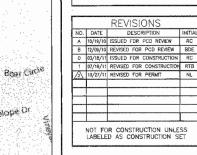


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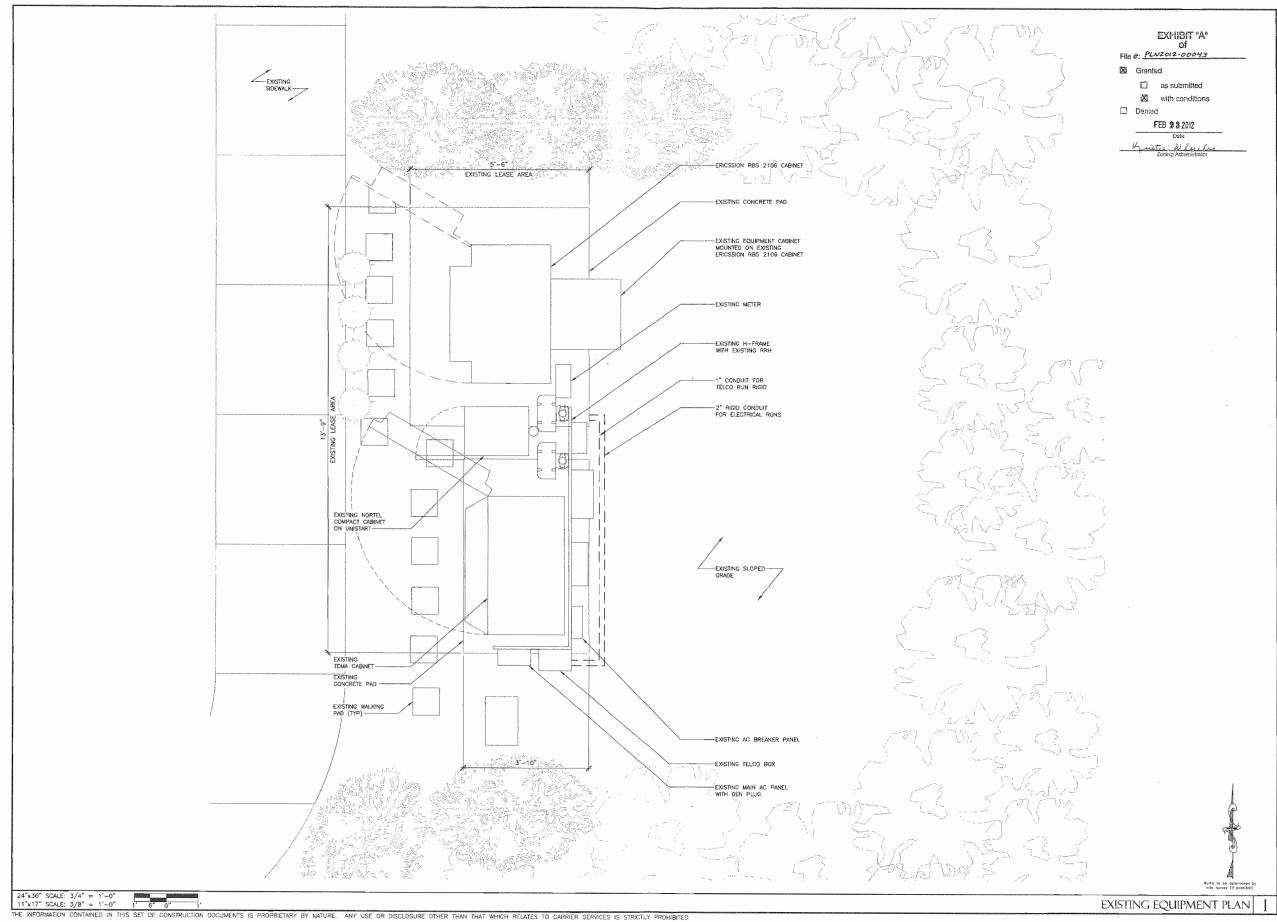
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SHEET TITLE SITE PLAN





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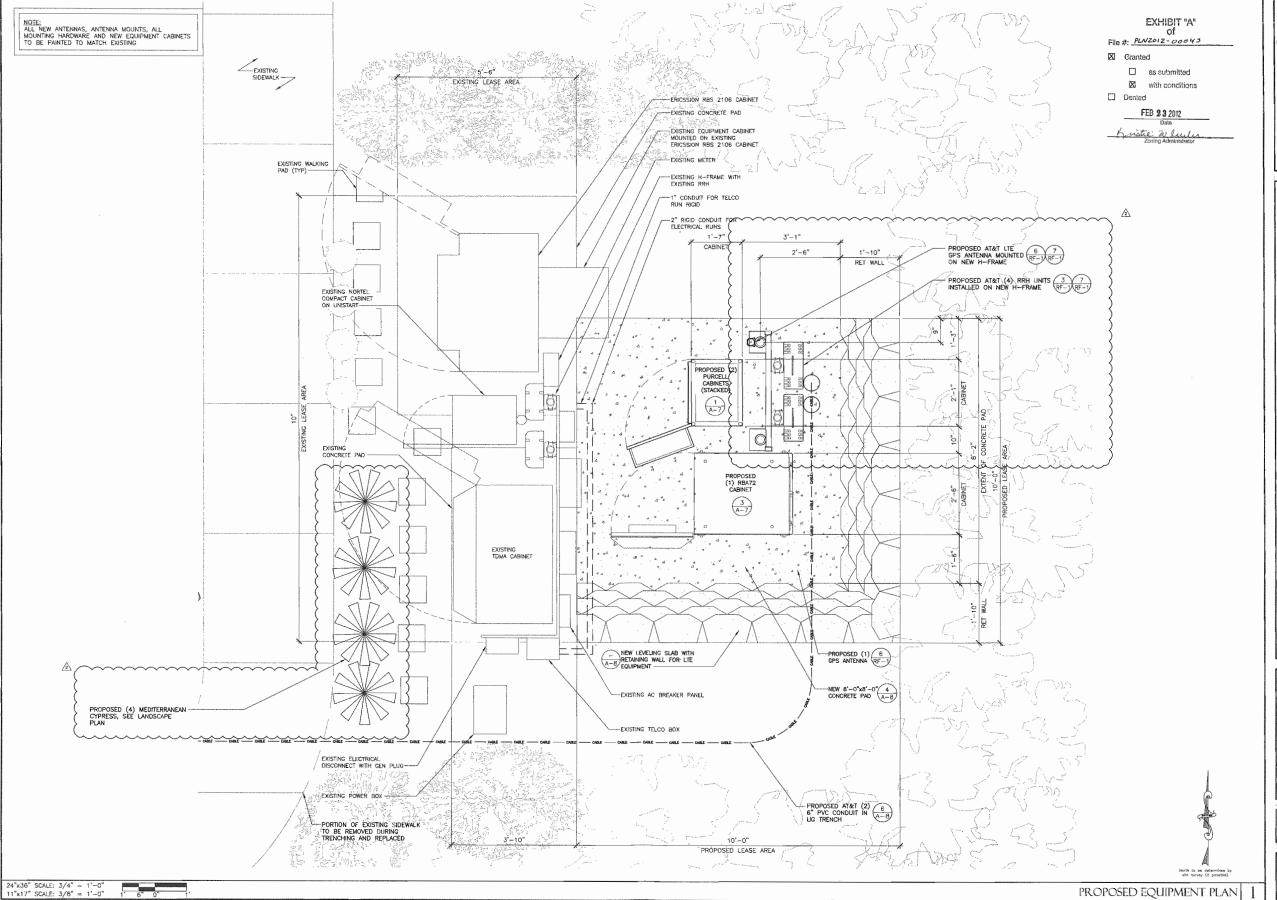


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SHEET TITLE EXISTING & PROPOSED EQUIPMENT PLAN





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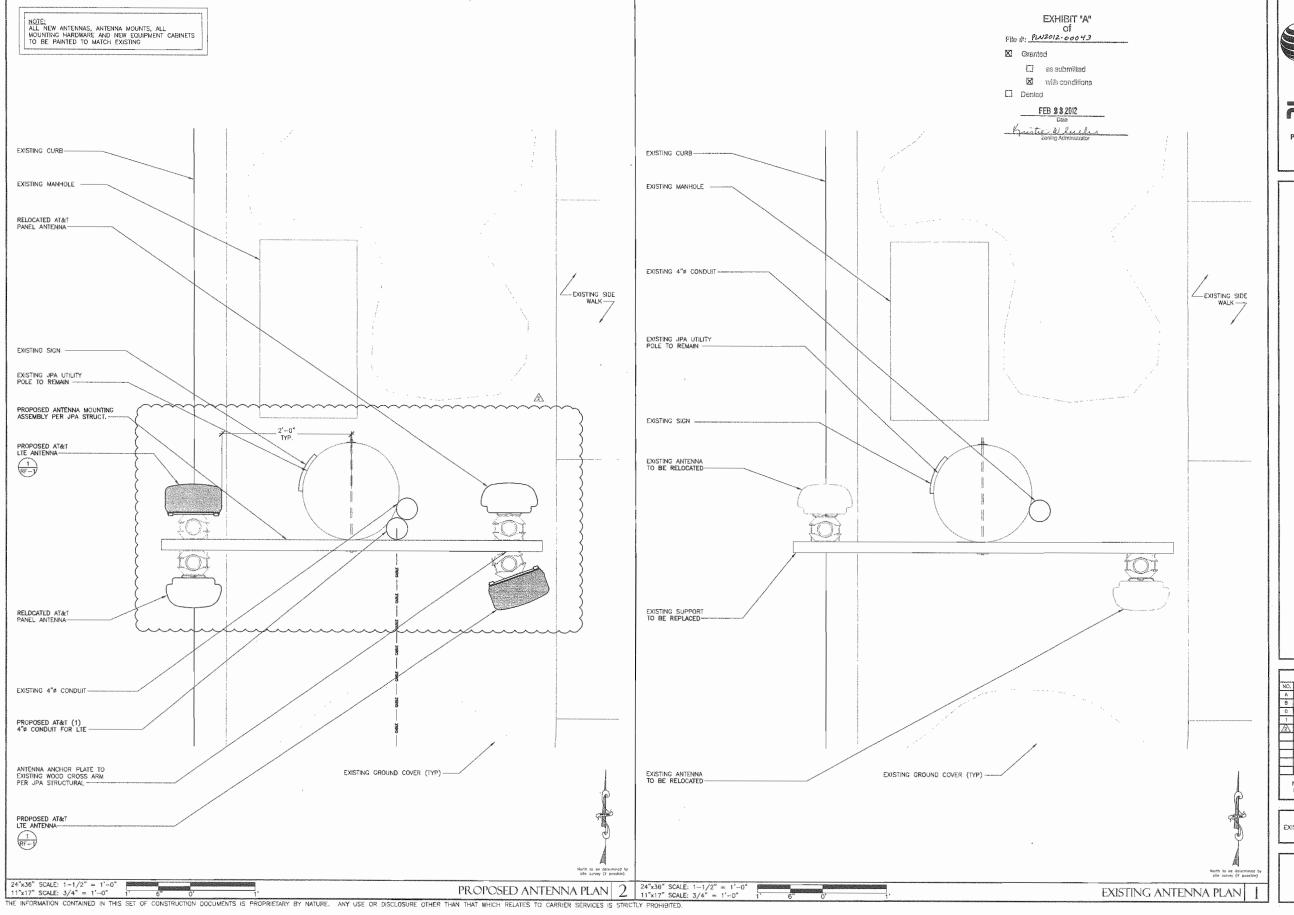


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SHEET TITLE PROPOSED EQUIPMENT PLAN












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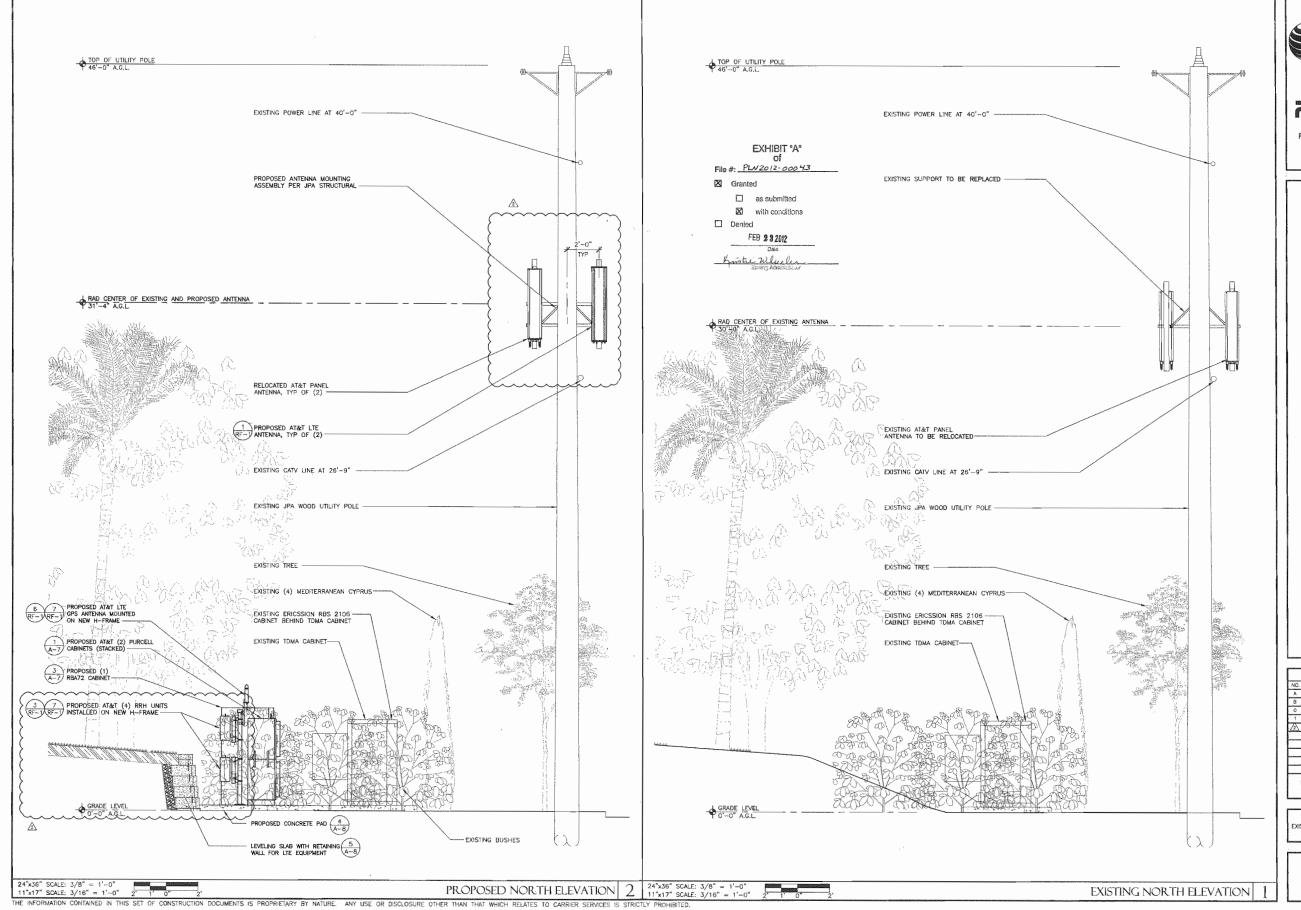
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SHEET TITLE EXISTING & PROPOSED SOUTH ELEVATION

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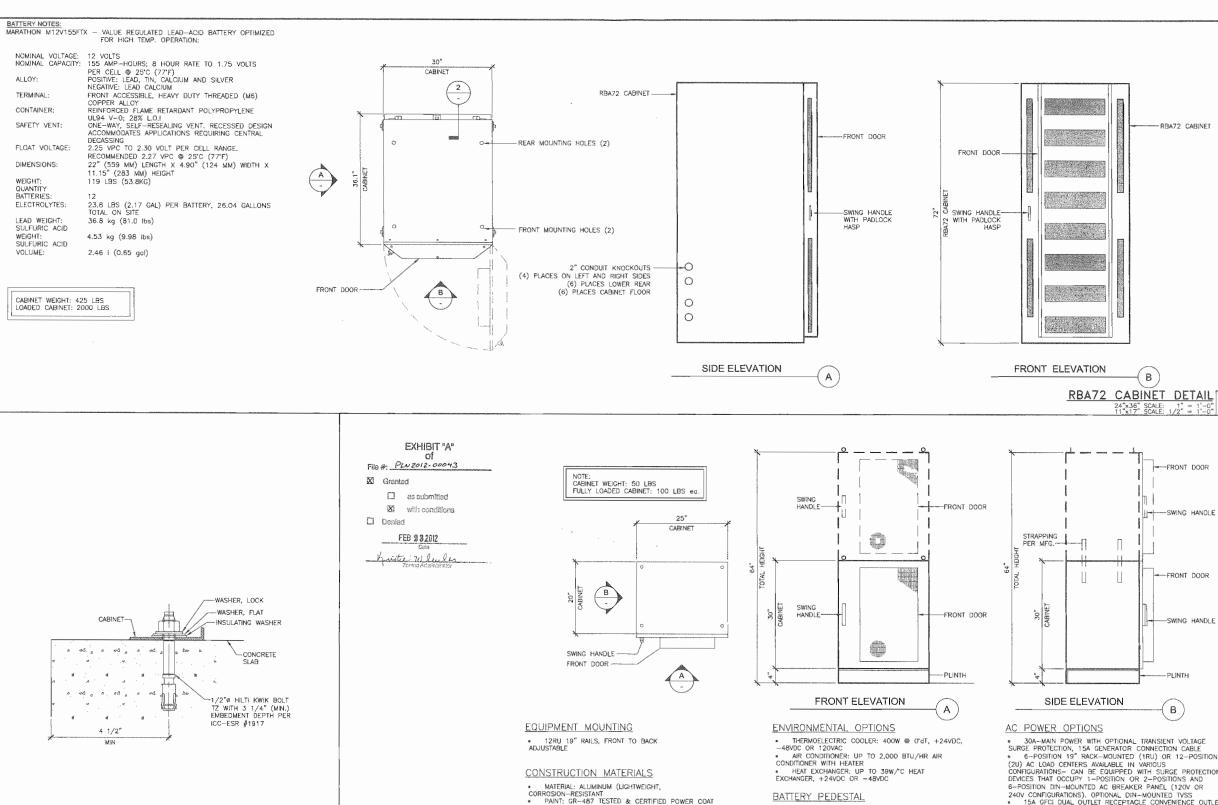


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SHEET TITLE EXISTING & PROPOSED NORTH ELEVATIO

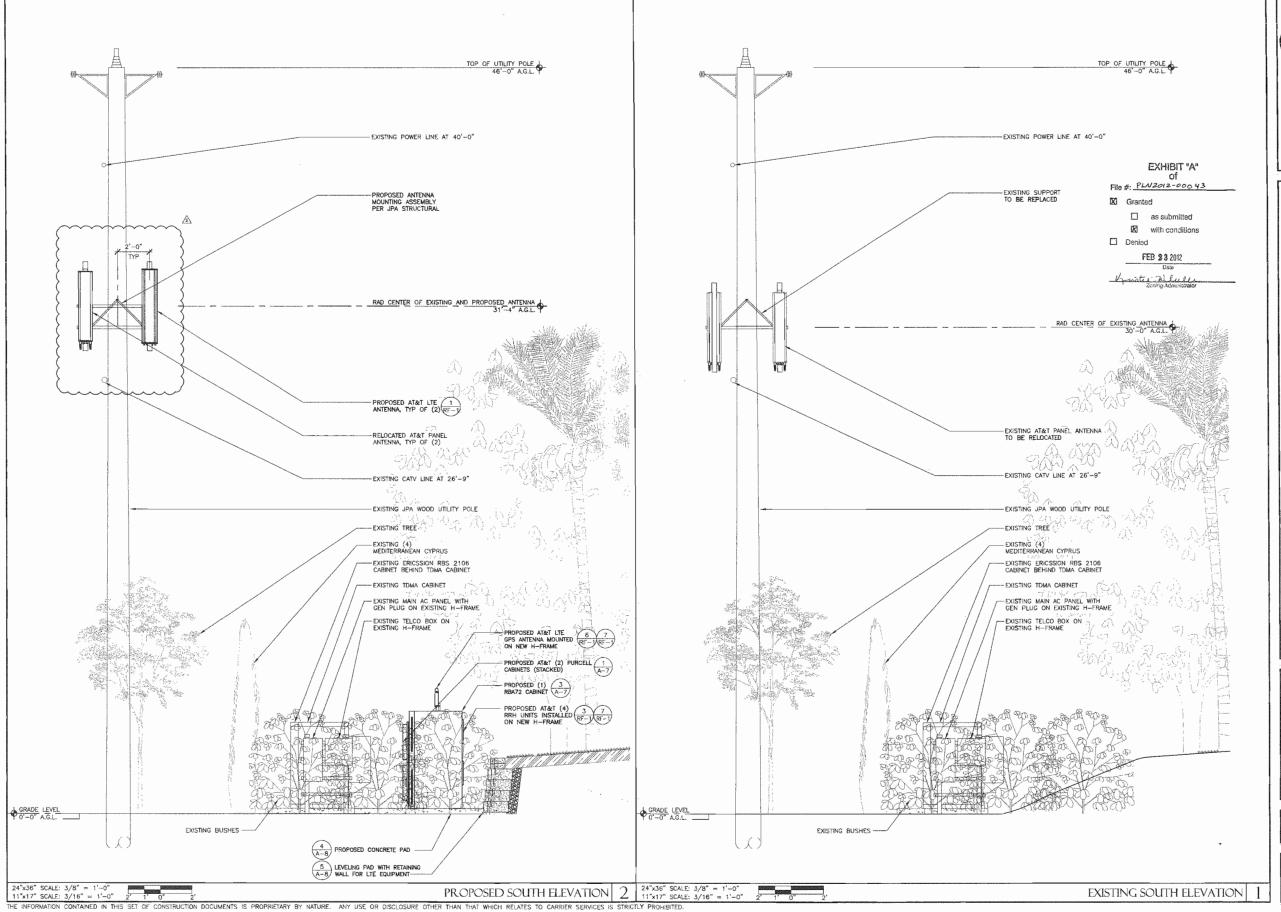



DOOR/SIDE PANEL CONSTRUCTION

DOOR: FRONT DOOR WITH DOOR ALARM AND OPTIONAL AIR CONDITIONER, HEAT EXHANGER, OR THERMOELECTRIC COOLER
 LATCHES: TWO-POINT LATCHED, PAD LOCKABLE

30a—MAIN POWER WITH OPTIONAL TRANSIENT VOLTAGE SURGE PROTECTION, 15A GENERATOR CONNECTION CABLE
6—POSITION 19" RACK—MOUNTED (IRU) OR 12—POSITION (2U) AC LOAD CENTERS AVAILABLE IN VARIOUS CONIGURATIONS—CAN BE EQUIPPED WITH SURGE PROTECTION DEVICES THAT OCCUPY 1—POSITION OR 2—POSITIONS AND 6—POSITION DIN—MOUNTED AC BREAKER PANEL (120V OR 240V CONFIGURATIONS). OPTIONAL DIN-MOUNTED TYSS
15A GFCI DUAL OUTLET RECEPTACLE CONVENIENCE OUTLET

MOUNTING OPTIONS

4" PLINTH

· ACCOMMODATES UP TO 60AHR BATTERIES

• (3) 1/2"; (3) 1"; (1) 2" 31/2" OR 2" KNOCKOUTS

CABLE ENTRY

- 14" PUNTH
 POLE MOUNT KIT
 WALL MOUNT KIT
 VERTICAL CABINET—ON—CABINET STACKING

PURCELL CABINET DETAIL 24"x36" SCALE: 1" 11"x17" SCALE: 1/2"

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CABINET ANCHOR DETAIL

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- RBA72 CABINET

---FRONT DOOR

-SWING HANDLE

-FRONT DOOR

PLINTH

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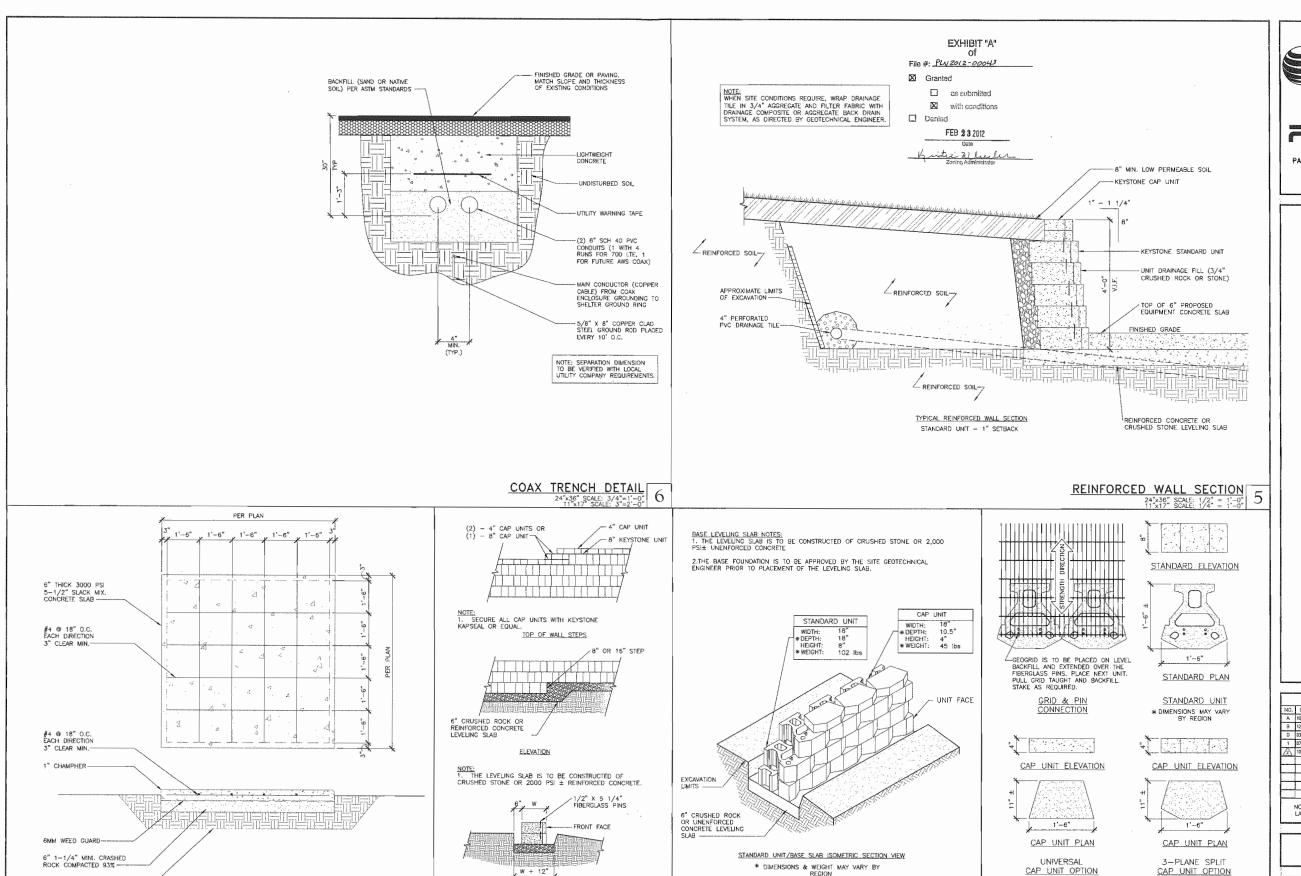
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SHEET TITLE EQUIPMENT DETAILS



SECTION

LEVELING SLAB DETAIL

24"x36" SCALE: 3/8" = 1'-0" 11"x17" SCALE: 3/16" = 1'-0" 3

LINDISTLIRRED FARTH

CONCRETE AND REINFORCING STEEL NOTES

24",35" SCALE: NOT TO SCALE
11 x17" SCALE: NOT TO SCALE

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> SHEET TITLE CONSTRUCTION DETAILS

SHEET NUMBER 4-8

* DIMENSIONS & AVAILABILITY WILL VARY BY REGION


ISOMETRIC WALL SECTION

24"x36" SCALE: 3/8" = 1'-0" 11"x17" SCALE: 3/16" = 1'-0"

* DIMENSIONS & AVAILABILITY WILL VARY BY REGION

KEYSTONE UNIT

24"x36" SCALE: 3/8" = 1'-0' 11"x17" SCALE: 3/16" = 1'-0'

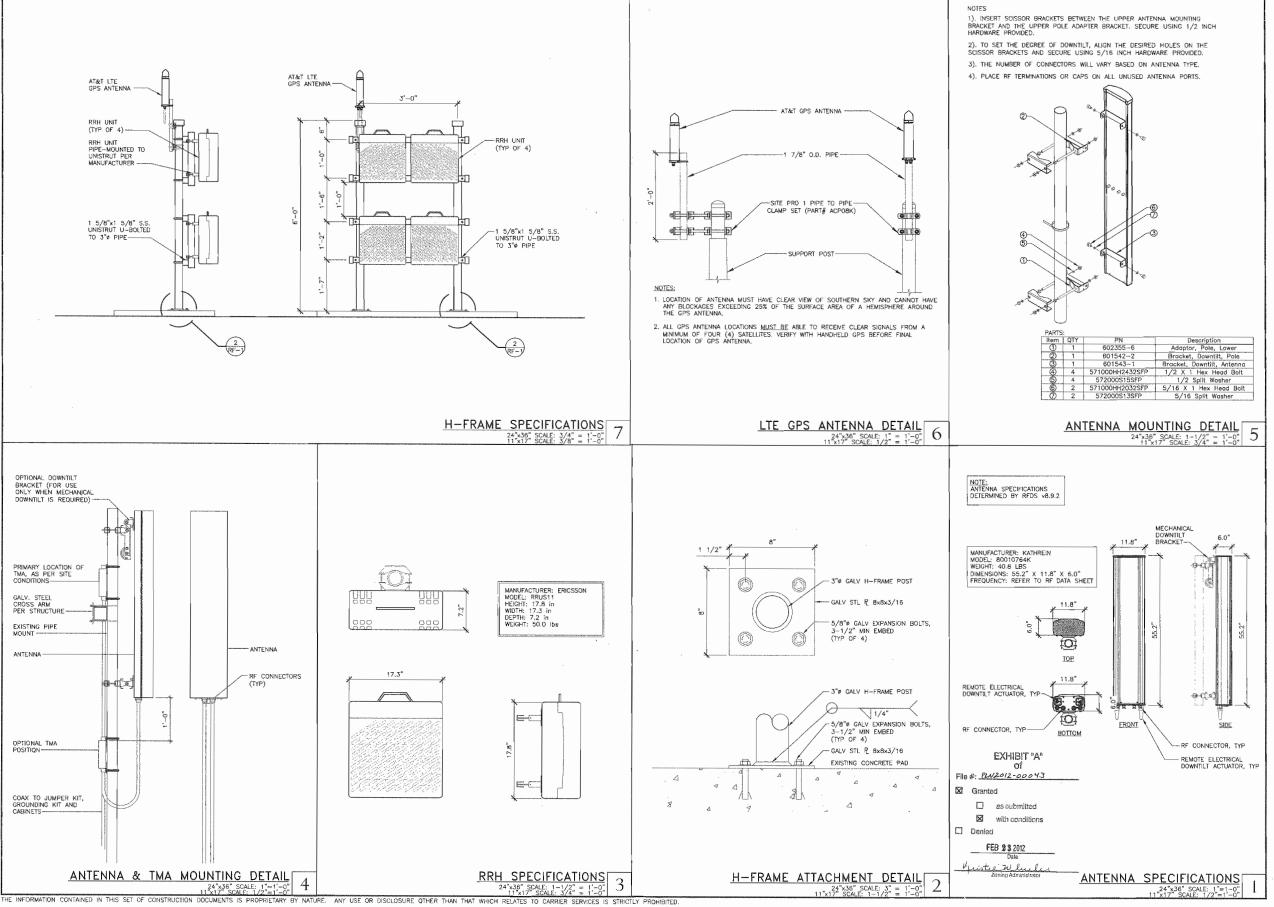

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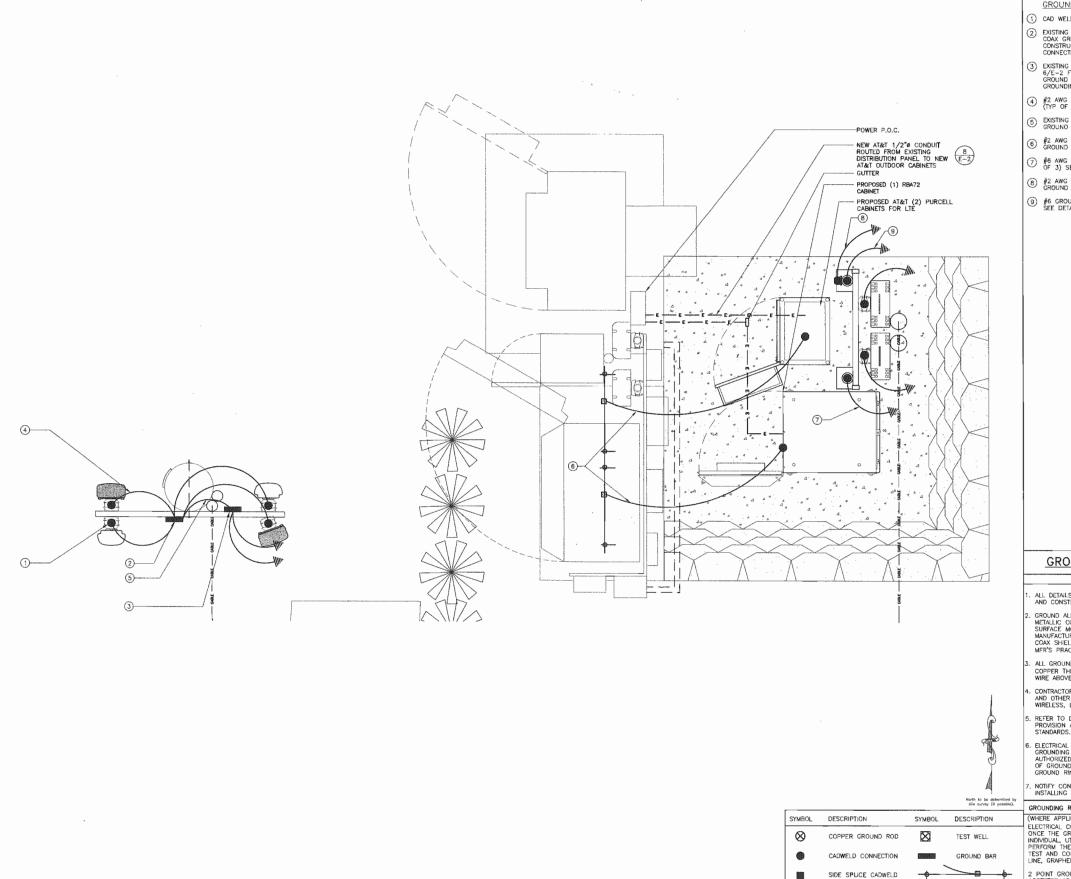
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> SHEET TITLE RF DETAILS



SCHEMATIC GROUNDING PLAN 1

21 x30 SCALE: 3/8" = 1'-0"

11"x17" SCALE: 3/16" = 1'-0"

2' 1' 0"

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GROUNDING KEYED NOTES:

- 1) CAD WELD (TYP). SEE DETAIL 2/E-2.
- EXISTING ANTENNA GROUND BUS BAR NEAR ANTENNA MOUNT WITH COAX GROUND KIT. SEE OETAIL 6/E-2 FOR GROUND BAR CONSTRUCTION, SEE DETAIL 7/E-2 FOR GROUND WIRE CONNECTIONS, AND SEE DETAIL 4/E-2 FOR COAX GROUNDING.
- 3 EXISTING POLE GROUND BUS BAR AT BASE OF POLE. SEE DETAIL 6/E-2 FOR GROUND BAR CONSTRUCTION, SEE DETAIL 7/E-2 FOR GROUND WIRE CONNECTIONS, AND SEE DETAIL 4/E-2 FOR COAX GROUNDING.
- #2 AWG ANTENNA MOUNT GROUND TO ANTENNA GROUND BUS BAR (TYP OF 3) SEE DETAIL 7/E-2.
- (5) EXISTING GROUND FROM ANTENNA GROUND BUS BAR TO POLE GROUND BUS BAR (TYP OF (2) PLACES). SEE DETAIL 7/E-2.
- 7) #6 AWG RRH MOUNT GROUND TO ANTENNA GROUND BUS BAR (TYOF 3) SEE DETAIL 7/E-2.
- (8) #2 AWG GPS ANTENNA GROUND TO TIE INTO EXISTING EQUIPMENT GROUND BUS BAR (TYP OF 3 PLACES) SEE DETAIL 7/E-2.
- #6 GROUND FROM SUPPORT POST TO MAIN GROUND BUS BAR. SEE DETAIL 7/E-2.

EXHIBIT "A"

File #: PLNZ012-00043

☑ Granted

as submitted

with conditions

Denied

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GROUNDING NOTES & LEGEND

GENERAL GROUNDING NOTES

- ALL DETAILS ARE SHOWN IN GENERAL TERMS, ACTUAL INSTALLATION AND CONSTRUCTION MAY VARY DUE TO SITE SPECIFIC CONDITIONS.
- . GROUND ALL ANTENNA BASES, FRAMES, CABLE RUNS, AND OTHER METALLIC COMPONENTS USING GROUND WIRES AND CONNECT TO SURFACE MOUNTED BUS BARS, FOLLOW ANTENNA AND BTS MANUFACTURERS PRACTICES FOR GROUNDING REQUIREMENTS, GROUND COAX SHIELD AT BOTH ENDS AND EXIT FROM TOWER OR POLE USING MFR'S PRACTICES.
- . ALL GROUND CONNECTIONS SHALL BE CADWELD. ALL WIRES SHALL BE COPPER THHN/THWN. ALL GROUND WIRE SHALL BE GREEN INSULATED WIRE ABOVE GROUND.
- . CONTRACTOR TO VERIFY AND TEST GROUND TO SOURCE. GROUNDING AND OTHER OPERATIONAL TESTING WILL BE WITNESSED BY AT&T WIRELESS, LLC. REPRESENTATIVE.
- i, REFER TO DIVISION 16 GENERAL ELECTRIC; GENERAL ELECTRICAL PROVISION AND COMPLY WITH ALL REQUIREMENTS OF GROUNDING STANDARDS.
- 6. ELECTRICAL CONTRACTOR TO PROVIDE DETAILED DESIGN OF GROUNDING SYSTEM, AND RECEIVE APPROVAL OF DESIGN BY AUTHORIZED AT&T MOBILITY REPRESENTATIVE, PRIOR TO INSTALLATION OF GROUNDING SYSTEM. PHOTO DOCUMENT ALL CADWELDS AND GROUND RING
- , NOTIFY CONSTRUCTION MANAGER IF THERE ARE ANY DIFFICULTIES INSTALLING GROUNDING SYSTEM DUE TO SITE SOIL CONDITIONS.

GROUNDING ROD NOTES

FIELD VERIFY & TIE INTO EXISTING GROUNDING SYSTEM

(WHERE APPLICABLE)

ELECTRICAL CONTRACTOR SHALL ORDER GROUND RESISTANCE TESTING ONCE THE GROUND SYSTEM HAS BEEN INSTALLED; A QUALIFIED INDIVIDUAL, UTILIZING THE FALL OF POTENTIAL METHOD, SHOULD PERFORM THE TEST. THE REPORT WILL SHOW THE LOCATION OF THE TEST AND CONTIAN NO LESS THAN 9 TEST POINTS ALONG THE TESTING LINE, GRAPHED OUT TO SHOW THE PLATEAU.

2 POINT GROUND TEST OR 3 POINT 62% TESTS WILL NOT BE ACCEPTED AS ALTERNATIVES TO THE AFORE MENTIONED GROUND TESTS. SHALL BE PERFORMED WHILE THE COUNTERPOISE IS ISOLATED FROM THE A/C SYSTEM GRIDS AND EXISTING COMMUNICATIONS FACILITY.





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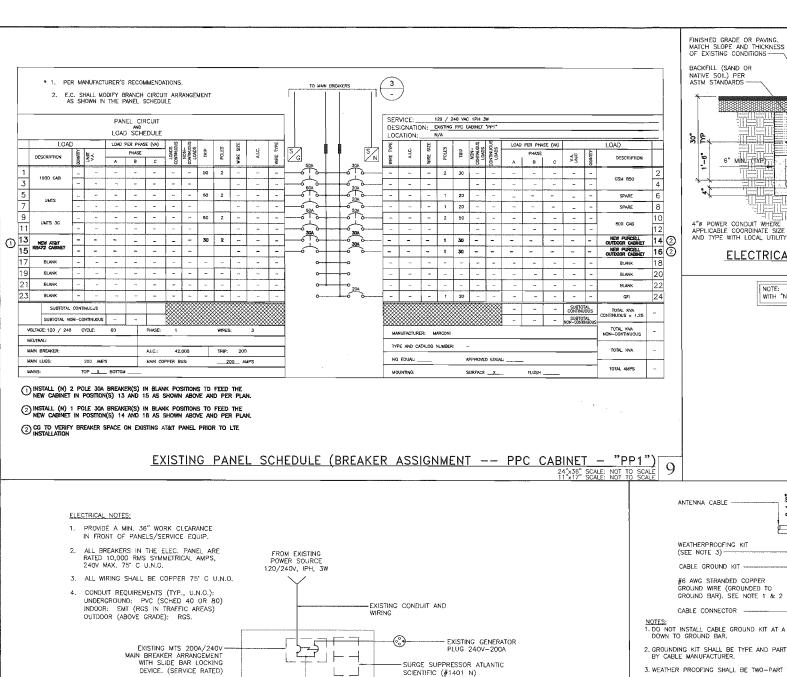
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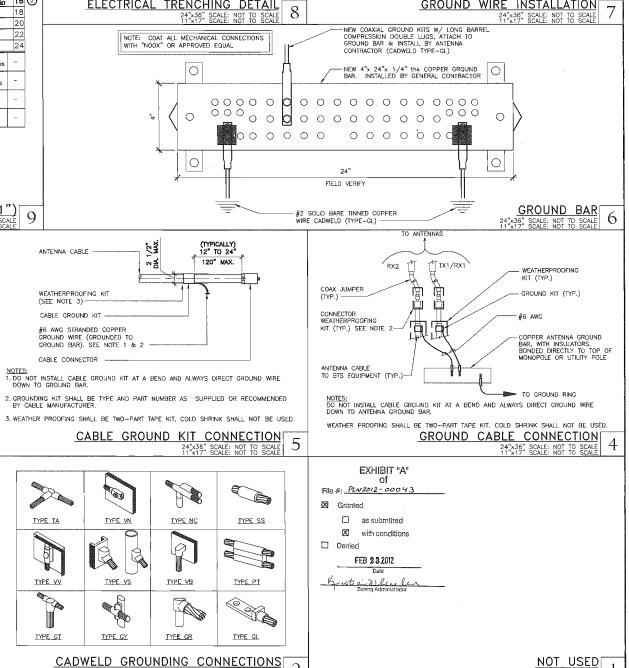
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SHEET TITLE SCHEMATIC GROUNDING PLAN





#6 AWG FROM ANTENNA CABLE GROUND KIT ----

GROUND BARS AT BOTTOM OF TOWERS/MONOPOLES SHALL ONLY USE EXOTHERMIC WELDS.

*TWO HOLE LUG, OR EXOTHERMIC WELD TO BE USED WITH #2 AWG BCW TO BUILDING SERVICE GROUND OR GROUND RING

COPPER GROUND

BAR ON WALL, ICE BRIDGE, FLOOR OR

NOTE:
SEPARATION DIMENSION TO BE
VERIFIED WITH LOCAL UTILITY
COMPANY REQUIREMENTS.

ELECTRICAL TRENCHING DETAIL

6" MIN. (TYP)

BACKFILL WITH
SATISFACTORY NATIVE
OR IMPORTED SOIL

UNDISTURBED SOIL

MIN TO SECONDARY ELECTRIC

MIN TO PRIMARY ELECTRIC

24"x36" SCALE: NOT TO SCALE



— GROUND CONDUCTOR SHALL
BE ELIMINATED WHEN
GROUND BAR IS
ELECTRICALLY BONDED TO
METAL TOWER/MONOPOLE
STRUCTURE

GROUND WIRE INSTALLATION



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SHEET TITLE GROUNDING DETAILS

SHEET NUMBER Γ

24"x36" SCALE; NOT TO SCALE

30A 30A

30A

1/2"ø, 2 #10, 1 #8 GND

ADD NEW 1 POLE, 30A BREAKER FOR (N) EQUIPMENT IN EXISTING BLANK POSITION 14

1/2°C, 3#12, 1#10GND [±20']

ADD NEW 1 POLE, 30A BREAKER FOR (N) EQUIPMENT IN EXISTING BLANK POSMON 16

NEW AT&T PURCELL CABINET OUTDOOR ENDER

CABINET

NEW AT&T
PURCELL CABINET

OUTDOOR FOURMENT

EXISTING PPC - "PP1"

EXISTING 42KHC 200A 120/240

MARCONI PPC CABINET "PP1", UL

EXISTING AT&T 24-POSITION LOAD-CENTER INSIDE EXISTING CABINET [PANEL 1-A]


RBA72 OUTDOOR

EQUIPMENT CABINET

1/2°C, 3#10, 1#8GND [±25]

ADD NEW 2 POLE, 30A BREAKER-FOR (N) EQUIPMENT IN EXISTING BLANK POSITIONS 13 AND 15

APPROVED (LOCATED INSIDE EXISTING

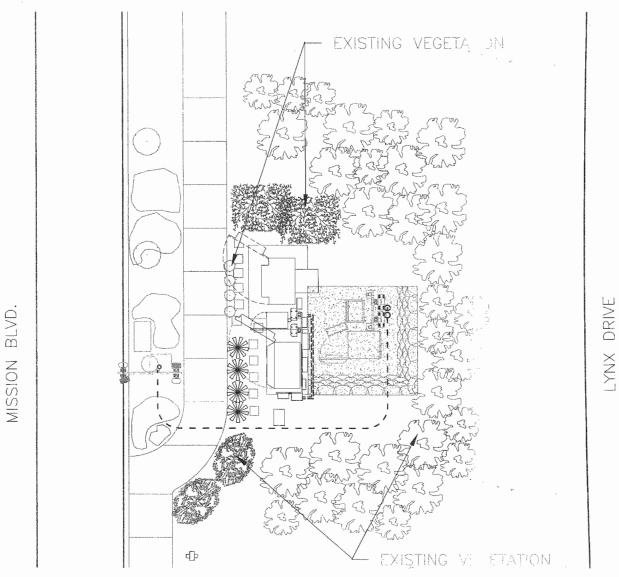





PLANT LEGEND

Quantity	Symbol	Scientific Nam	е	Common Name	Planting Size
4	*	Cupressus sen	np. 'Tiny Towers'	Italian Cypress	5-Gal

PLANTING & IRRIGATION NOTES:

- 1. EXISTING SHRUBS ARE TO REMAIN. PRUNE ONLY IF NECESSARY AFTER OBTAINING CITY APPROVAL.
- 2. PLANT NEW SHRUBS AS SHOWN ON PLAN TO SCREEN EQUIPMENT.
- 3. MAKE MODIFICATIONS TO IRRIGATION SYSTEM TO INSURE NEW PLANTS ARE WATERED.
- 4. TOP DRESS DISTURBED AREA WITH 3" OF 3/4" TO 1" BARK.
- 5. MAINTAIN NEW PLANTS FOR 90 DAYS. REPLACE ANY PLANTS AT THE END OF MAINTENANCE PERIOD THAT ARE NOT IN GOOD SHAPE.

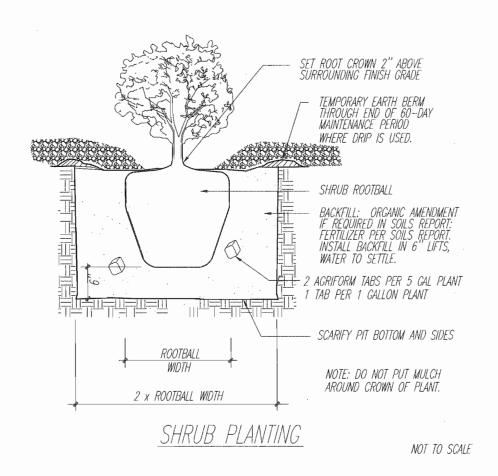

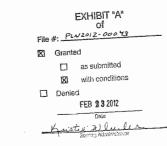






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LANDSCAPE PLAN



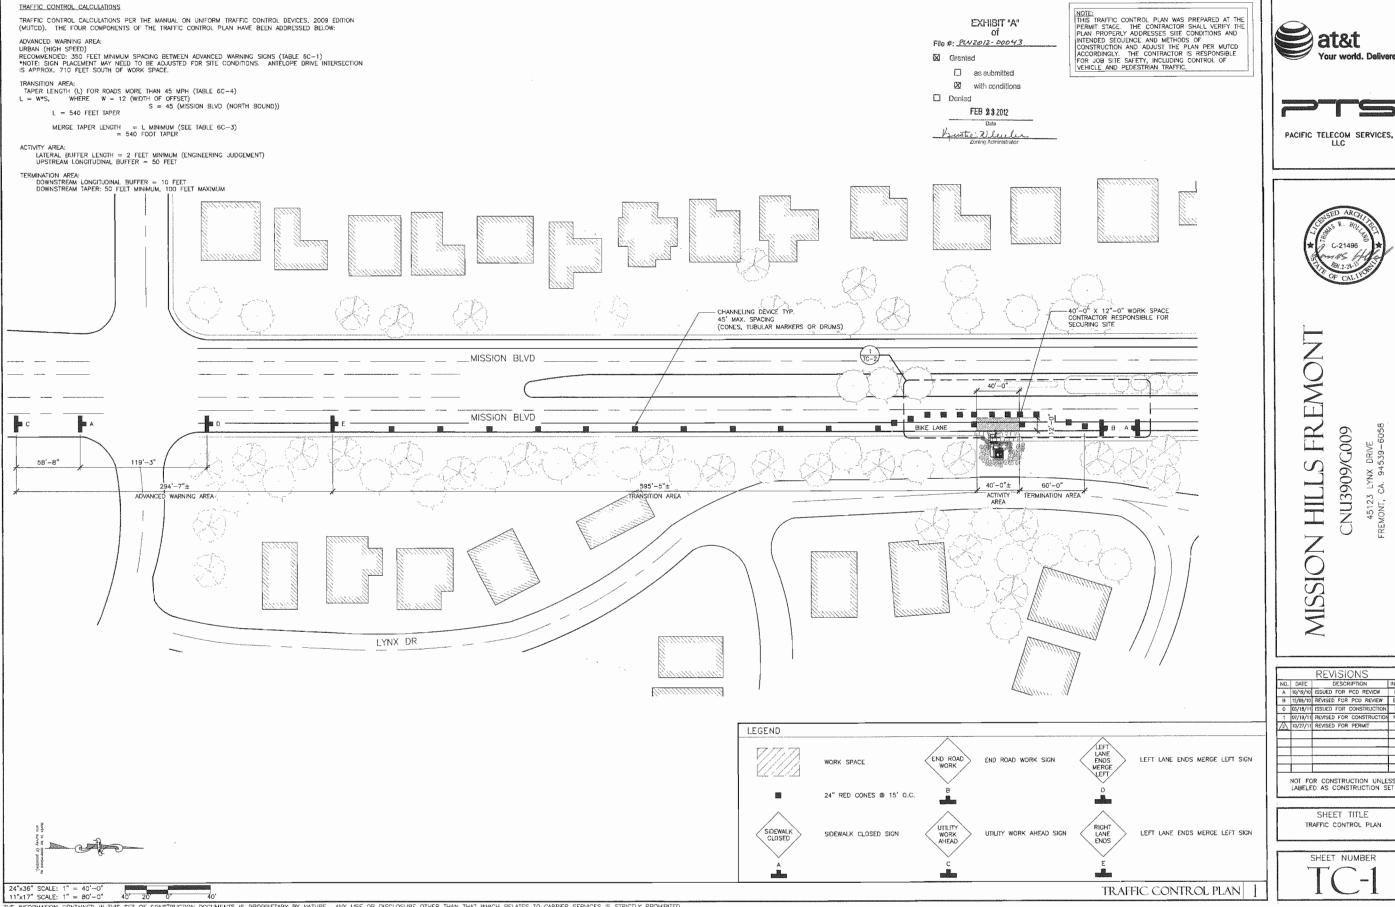




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> SHEET TITLE TRAFFIC CONTROL PLAN







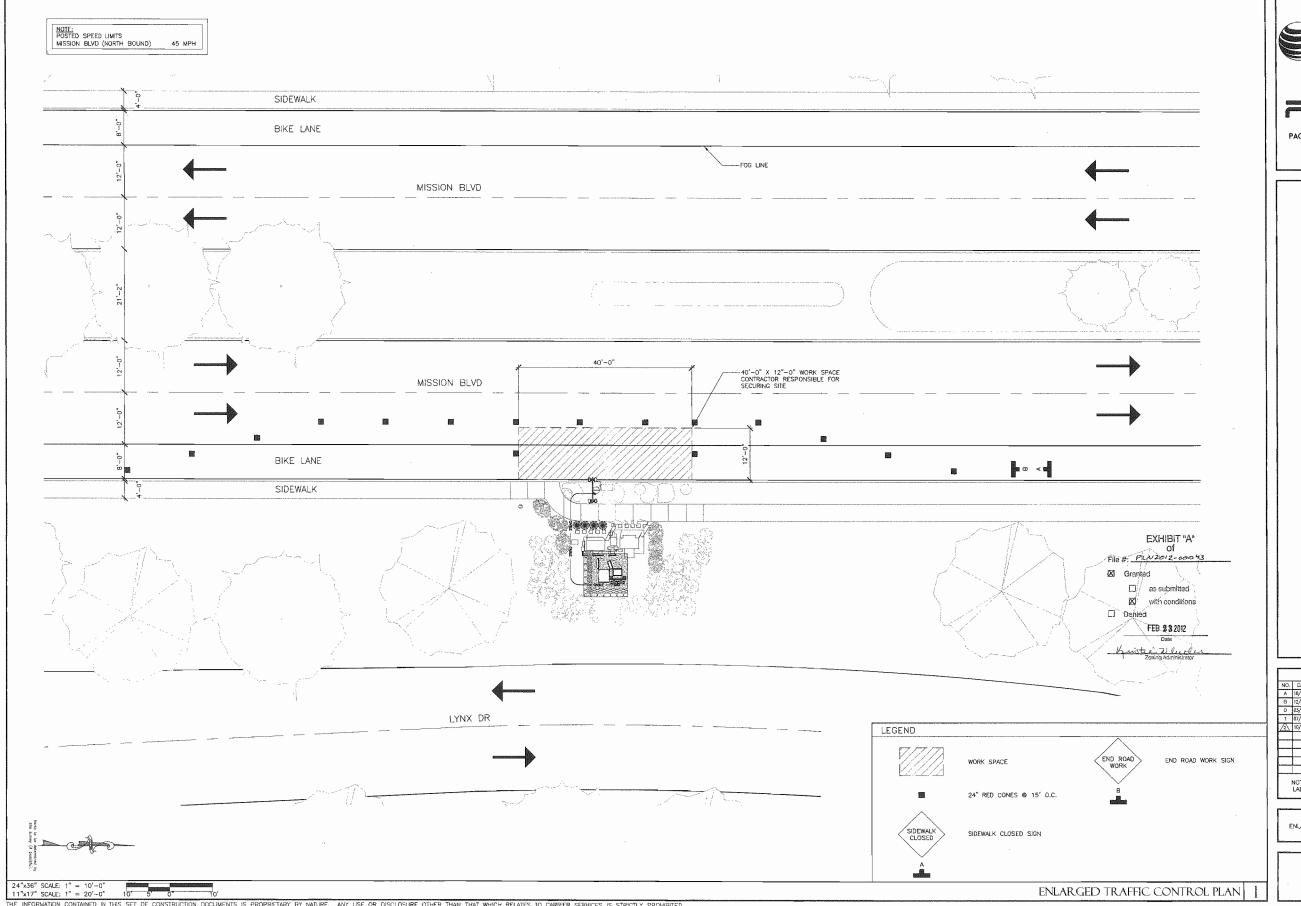

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SHEET TITLE ENLARGED TRAFFIC CONTROL PLAN